




1 Proposed West Elevation  
 A3.0 Scale: 1/8" = 1'-0"

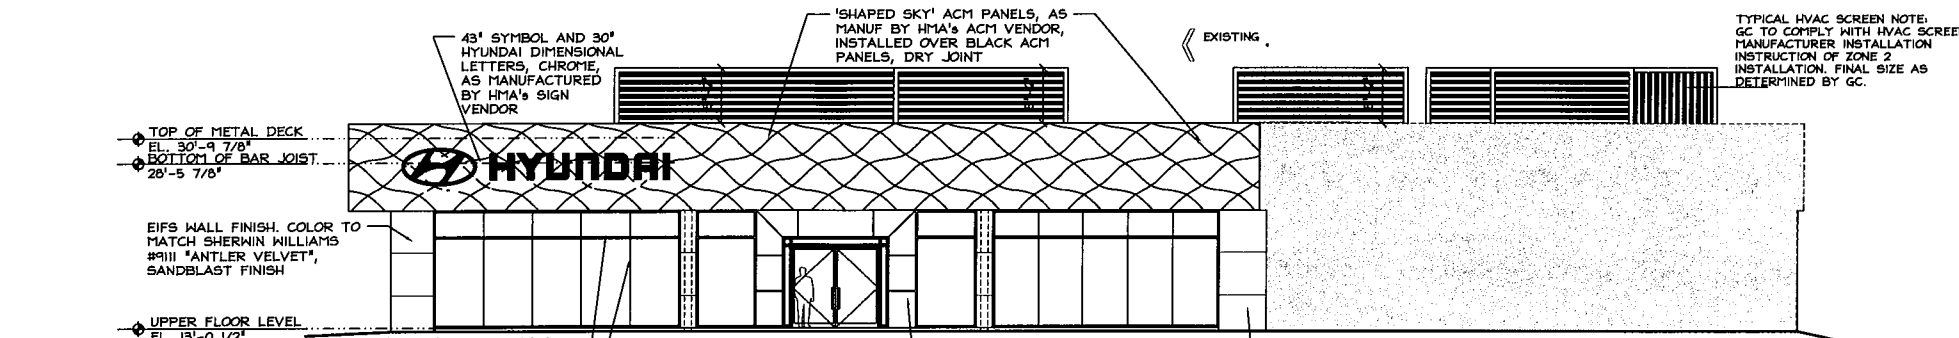


2 Proposed Partial West Elevation  
 A3.0 Scale: 1/8" = 1'-0"

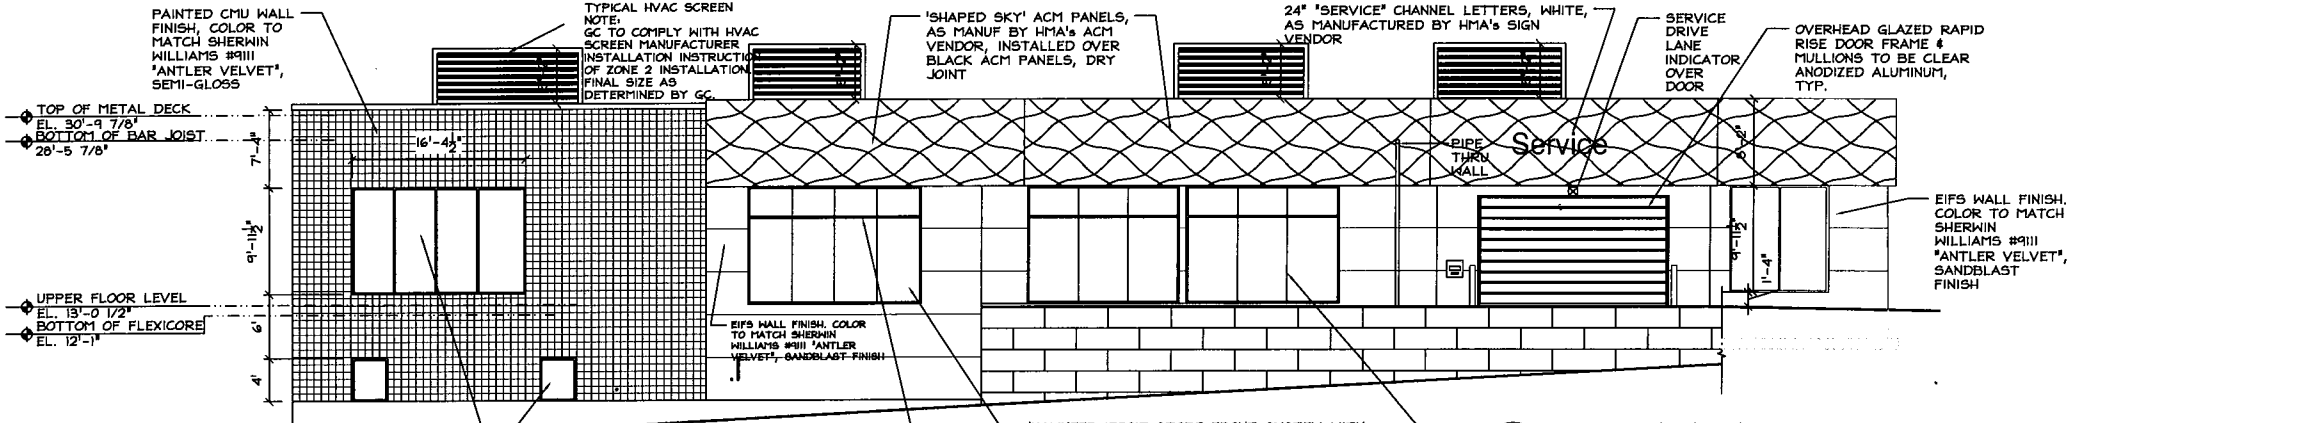

3 Proposed North Elevation  
 A3.0 Scale: 1/8" = 1'-0"

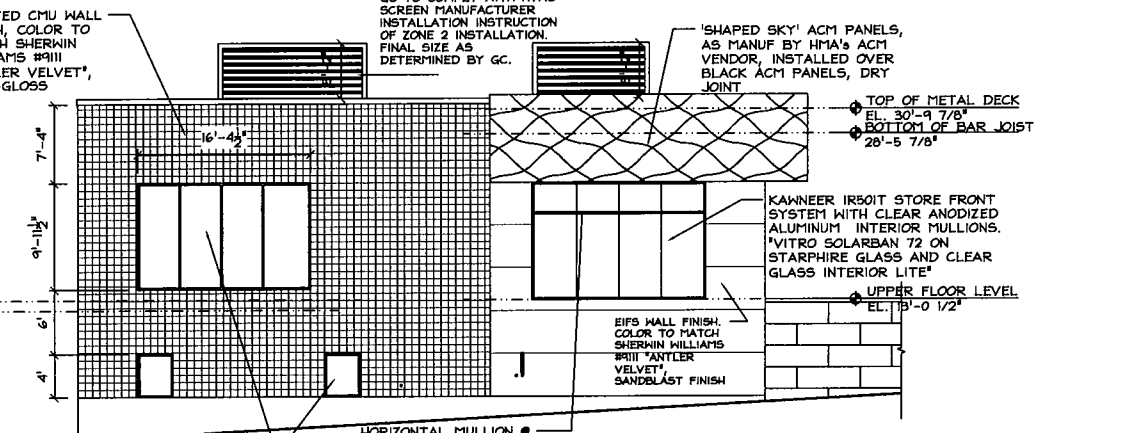

4 Proposed Partial North Elevation  
 A3.0 Scale: 1/8" = 1'-0"

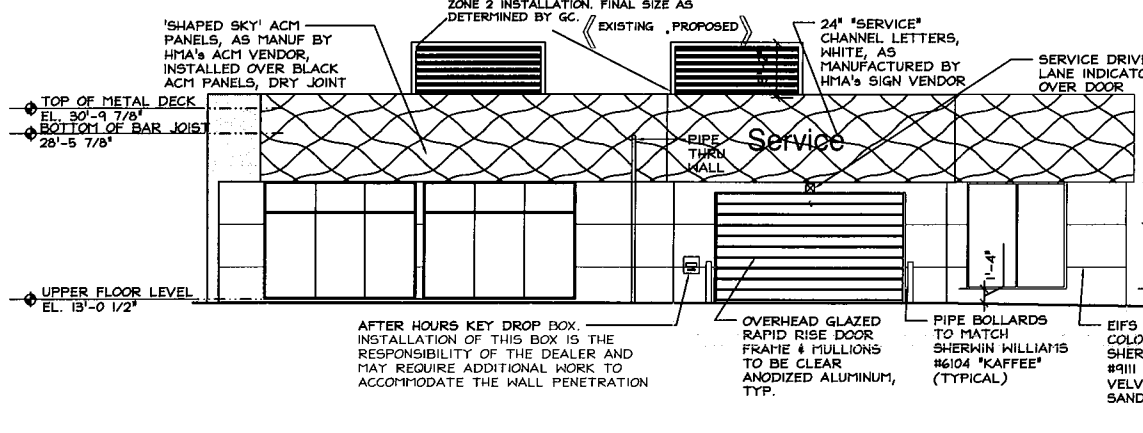

5 Partial North Elevation  
 A3.0 Scale: 1/8" = 1'-0"

Professional Engineer Seal  
 State of Rhode Island  
 License No. 02220  
 Thomas L. Conrado  
 Certification for Architectural work only.

Structural Mechanical Electrical, Fire  
 Alarm & Fire Protection by DBC.  
 Engineer's Name & Info


THOMAS L. CONRADO + ASSOCIATES ARCHITECTS inc.  
 INTERIOR DESIGNERS | PLANNERS  
 80 Alwood Avenue Cranston Rhode Island 02920  
 t:401.944.2800 f:401.944.2801 www.tlaarchitects.com

Project: Existing Condition Drawing Prepared for:  
**Newport Hyundai**  
**1215 West Main Road**  
**Middletown Rhode Island 02842**


Drawn by: JC, TSP, TDL  
 Checked by: TDL  
 Revised on:

Drawing Status  
**Planning**  
 Documents  
 Issued On April 12, 2022  
 Sheet Contents  
**Proposed North & West Elevations**  
 Project Number: 2102  
 Drawing No.

**A3.0**  
 Sheet 16 of 31

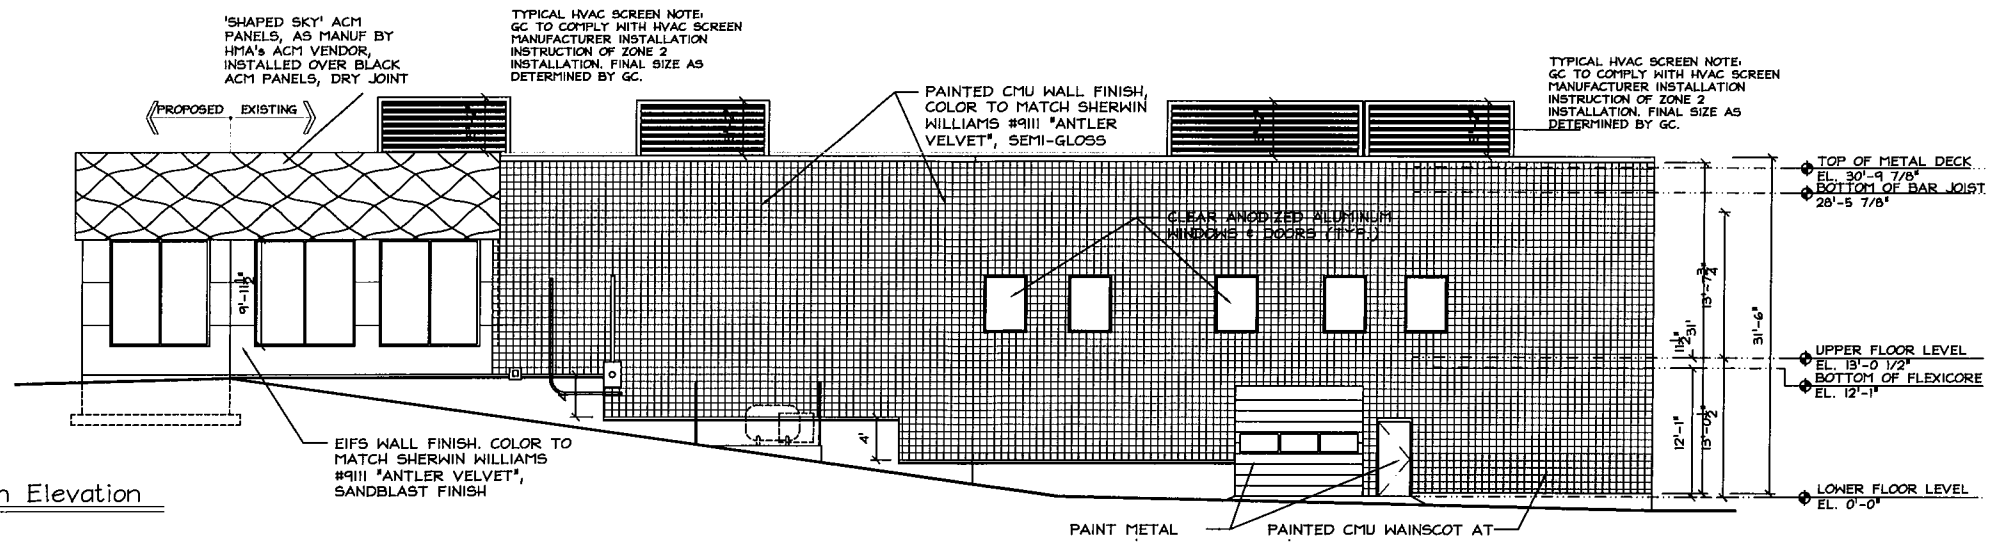

1 Proposed South Elevation  
A3.1 Scale: 1/8" = 1'-0"

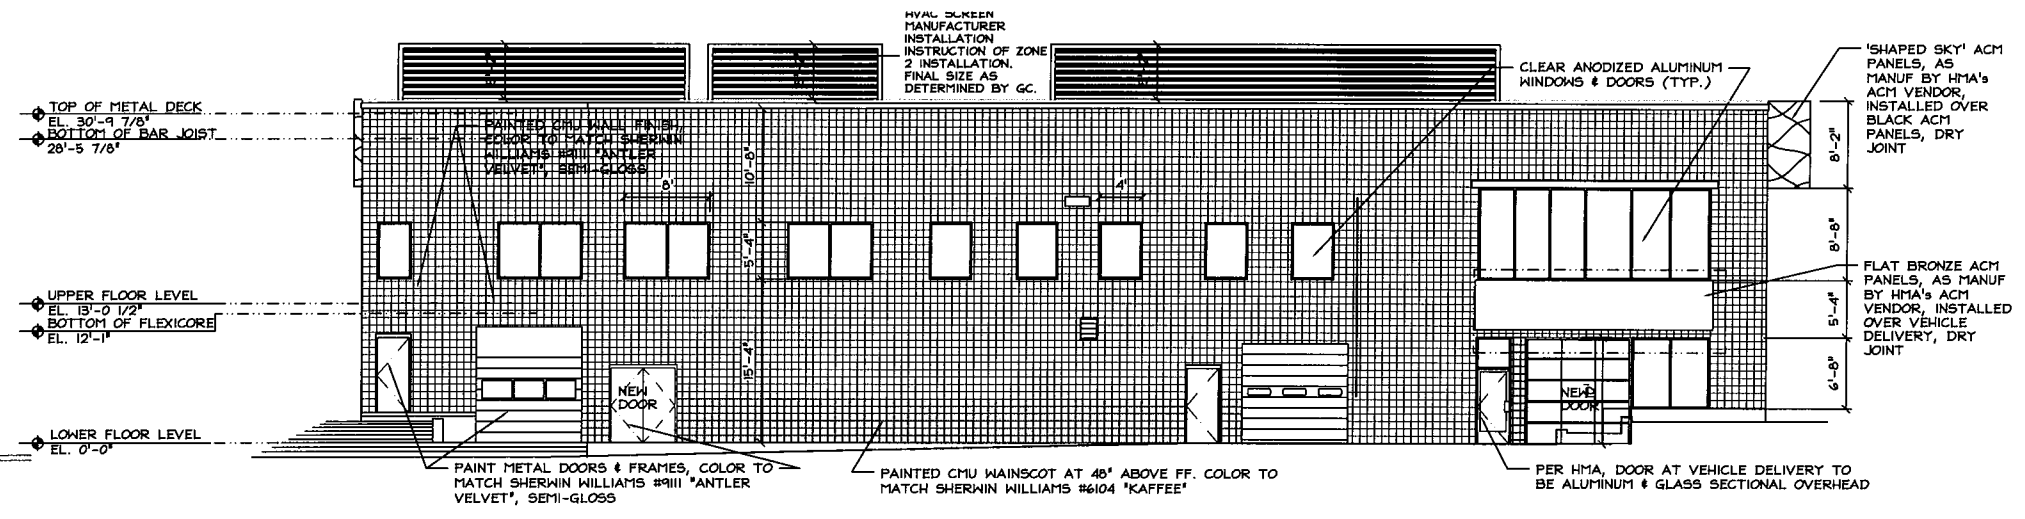

2 Proposed East Elevation  
A3.1 Scale: 1/8" = 1'-0"

The Engineer or Architect shall be responsible for the accuracy of the information provided in this drawing. The Engineer or Architect shall be responsible for the accuracy of the information provided in this drawing. The Engineer or Architect shall be responsible for the accuracy of the information provided in this drawing.

Structural, Mechanical, Electrical, Fire Alarm & Fire Protection By DBC.  
Engineer's Name & Info

THOMAS LONARDO + ASSOCIATES ARCHITECTS INC.  
INTERIOR DESIGNERS | PLANNERS  
80 Alwood Avenue Cranston Rhode Island 02920  
t:401.944.2600 f:401.944.2601 www.tlaarchitects.com

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Drawn by JC, TSP, TDL  
Checked by TDL  
Revised on

Drawing Status  
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Sheet Contents  
Proposed South & East Elevations

Project Number: 2102  
Drawing No.  
A3.1  
Sheet 17 of 31